-AIR BARRIER=

Thermal Envelop

TABLE R402.4.1.1
R BARRIER and INSULATION INSTALLATION

COMPONENT	AIR BARRIER CRITERIA	INSULATION INSTALLATION CRITERIA
General requirements	A continuous air barrier shall be installed in the building envelope. Exterior thermal envelope contains a continuous air barrier. Breaks or joints in the air barrier shall be sealed.	Air-permeable insulation shall not be used as a sealing material.
Celling/attic	The air barrier in any dropped ceiling/soffit shall be aligned with the insulation and any gaps in the air barrier shall be sealed. Access openings, drop down stair or knee wall doors to unconditioned attic spaces shall be sealed.	The insulation in any dropped ceiling/soffit shall be aligned with the air barrier.
Walls	The junction of the foundation and sill plate shall be sealed. The junction of the top plate and top of exterior walls shall be sealed. Knee walls shall be sealed.	Cavities within corners and headers of frame walls shall be insulated by completely filling the cavity with a material having a thermal resistance of R-3 per inch minimum. Exterior thermal envelope insulation for framed walls shall be installed in substantial contact and continuous alignment with the air barrier.
Windows, skylights and doors	The space between window/door jambs and framing and skylights and framing shall be sealed.	
Rim Joists	Rim joists shall include the air barrier.	Rim Joists shall be insulated.
Floors (including above-garage and cantilevered floors)	The air barrier shall be installed at any exposed edge of insulation.	Floor framing cavity insulation shall be installed to maintain permanent contact with the underside of the subfloor decking, or floor framing cavity insulation shall be permitted to be in contact with the top side of shealthing, or continuous insulation installed on the underside of floor framing and extends from the bottom to the top of all perimeter floor framing members.
Crawl Space walls	Exposed earth in unvented crawl spaces shall be covered with a Class I vapor retarder with overlapping joints taped.	Where provided, instead of floor insulation, insulation shall be permanently attached to the crawlspace walls.
Shafts, penetrations	Duct shafts, utility penetrations, and flue shafts opening to exterior or unconditioned space shall be sealed.	
Narrow cavities		Batts in narrow cavities shall be cut to fit, or narrow cavities shall be filled by insulation that on installation readily conforms to the available cavity space.
Garage separation	Air sealing shall be provided between the garage and conditioned spaces.	
Recessed lighting	Recessed light fixtures installed in the building thermal envelope shall be sealed to the drywall.	Recessed light fixtures installed in the building thermal envelope shall be air tight and IC rated.
Plumbing and wiring		Batt insulation shall be cut neatly to fit around wiring and plumbing in exterior walls, or insulation that on installation readily conforms to available space shall extend behind piping and wiring.
Shower/tub on exterior wall	The air barrier installed at exterior walls adjacent to showers and tubs shall separate them from the showers and tubs.	Exterior walls adjacent to showers and tubs shall be insulated.
Electrical/phone box on exterior walls	The air barrier shall be installed behind electrical or communication boxes or air sealed boxes shall be installed.	
HVAC register boots	HVAC register boots that penetrate building thermal envelope shall be sealed to the subfloor or drywall.	
Concealed sprinklers	When required to be sealed, concealed fire sprinklers shall only be sealed in a manner that is recommended by the manutacturer. Caulking or other adhesive sealants shall not be used to fill volbe between fire sprinkler cover plates and walls or ceilings.	

GENERAL NOTES


- ALL DIMENSIONS ARE FROM FACE OF STUD TO FACE OF STUD UNLESS

 NOTED OTHERWISE
- 2. WINDOW SIZES INDICATED ON PLANS ARE NOTED BY APPROXIMATE ROUGH OPENING SIZE, REFER TO PLANS AND EXTERIOR ELEVATIONS FOR WINDOW TYPES.
- 3. COORDINATE LOCATION OF UTILITY METERS WITH SITE PLAN AND LOCAT AWAY FROM PUBLIC VIEW. VISUAL IMPACT SHALL BE MINIMIZED, I.E. M OUNT AS LOW AS POSSIBLE.
- CONTRACTOR SHALL COORDINATE ALL CLOSET SHELVING REQUIREMENTS.
 CONTRACTOR SHALL FIELD VERIFY ALL CABINET DIMENSIONS BEFORE FABRICATION.
- 6. BEDROOM WINDOWS SHALL HAVE A MINIMUM NET CLEAR OPENING OF 5.7 SQFT A MINIMUM NET CLEAR OPENABLE WIDTH OF 20", A MINIMUM NET CLEAR OPENABLE HEIGHT OF 24" AND HAVE A MAXIMUM FINISH SILL HEIGHT OF 43" FROM FINISH FLOOR.
- 7. ALL GLASS LOCATED WITHIN 18" OF FLOOR, 12" OF A DOOR OR LOCATED WITHIN 60" OF FLOOR AT BATHTUBS, WHIRLPOOLS, SHOWERS, SAUNAS, STEAM ROOMS OR HOT TUBS SHALL BE TEMPERED.
- 8. PROVIDE COMBUSTION AIR VENTS, WITH SCREEN AND BACK DAMPER, FOR FIREPLACES, WOOD STOVES AND ANY APPLIANCE WITH AN OPEN FLAME.
- 9. BATHROOMS AND UTILITY ROOMS SHALL BE VENTED TO THE OUTSIDE WITH A MINIMUM OF A 40 CFM FAN. RANGE HOODS SHALL ALSO BE VENTED TO OUTSIDE.
- 10. ATTIC HVAC UNITS SHALL BE LOCATED WITHIN 20' OF ITS SERVICE OPENING. RETURN AIR GRILLES SHALL NOT BE LOCATED WITHIN 10 FEET OF A GAS FIRED APPLIANCE.
- 11. ALL WALLS AND CEILINGS IN GARAGE AND GARAGE STORAGE AREAS TO HAVE 5/8" TYPE-X GYP. BOARD W/ 1-HOUR FIRE RATING. ALL EXT. DOORS IN GARAGE TO BE METAL OR SOLID CORE DOORS INCLUDING DOORS ENTERING HEAT/COOLED PORTION OF RESIDENCE.
- 12. ALL INTERIOR WALLS SHALL BE COVERED WITH 1/2" GYPSUM BOARD, WITH METAL CORNER REINFORCING. TAPE FLOAT AND SAND. (3 COATS) USE 5/8" GYPSUM BOARD ON CEILING WHEN SUPPORTING MEMBERS ARE 24" O.C. OR GREATER USE 1/2" GYP. BOARD ON CEILING MEMBERS LESS
- 13. ALL BATH AND TOILET AREA WALLS AND CEILINGS SHALL HAVE WATER RESISTANT GYPSUM BOARD.
- 14. PERIMETER WALLS SHALL BE INSULATED WITH BATT INSULATION FIBER GLASS R-19.
- 15. ALL THE CEILING SHALL BE INSULATED WITH BATT INSULATION FIBER GLASS R-38.

Z-2022-10700290 CD

From: "R-6" Residential Single-Family District


To: "R-6 CD" Residential Single-Family District with a Conditional Use for Two (2) Dwelling Units

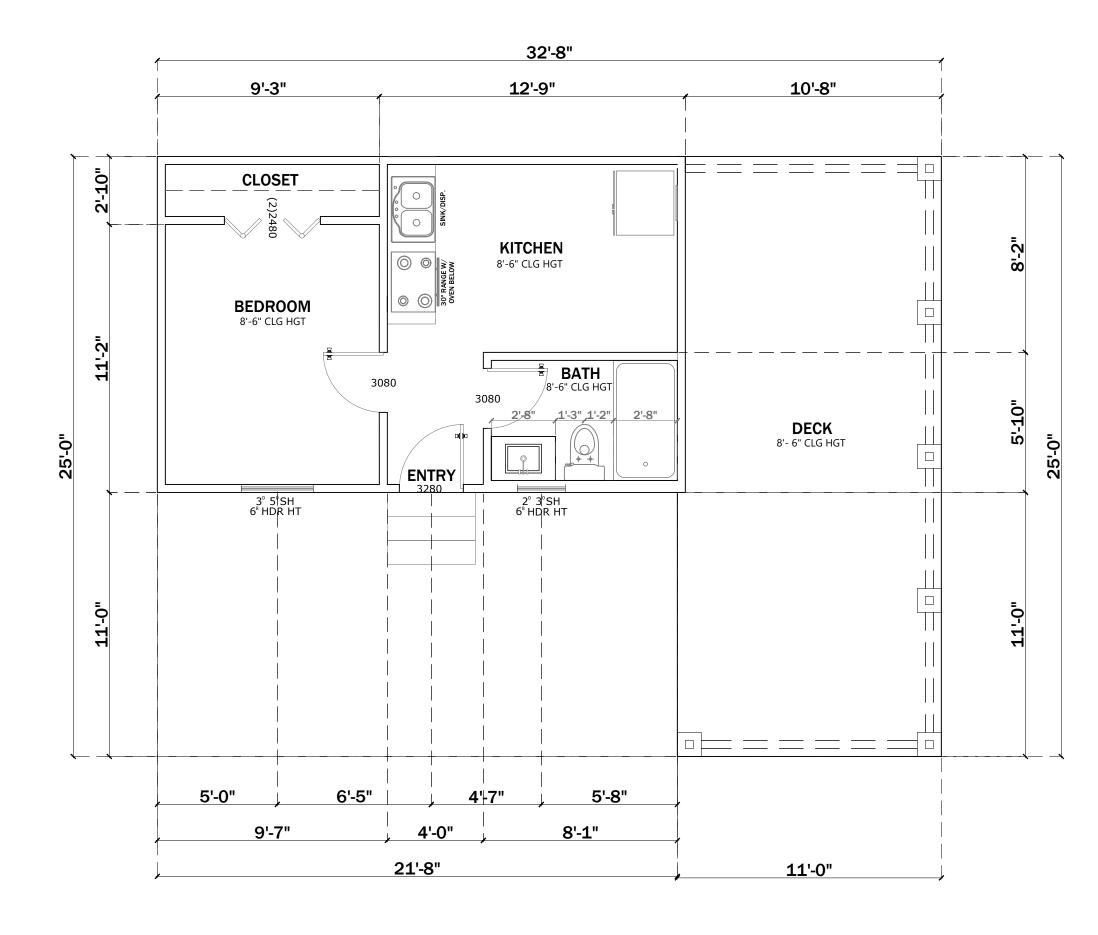


FIRST FLOOR (Unit 1)

105 Terrell Avenue

I, Bryan Maldonado, the property owner, acknowledge that this site plan submitted for the purpose of rezoning this property is in accordance with all applicable provisions of the Unified Development Code. Additionally, I understand that City Council approval of a site plan in conjunction with a rezoning case does not relieve me from adherence to any/all City-adopted Codes at the time of plan submittal for building permits.

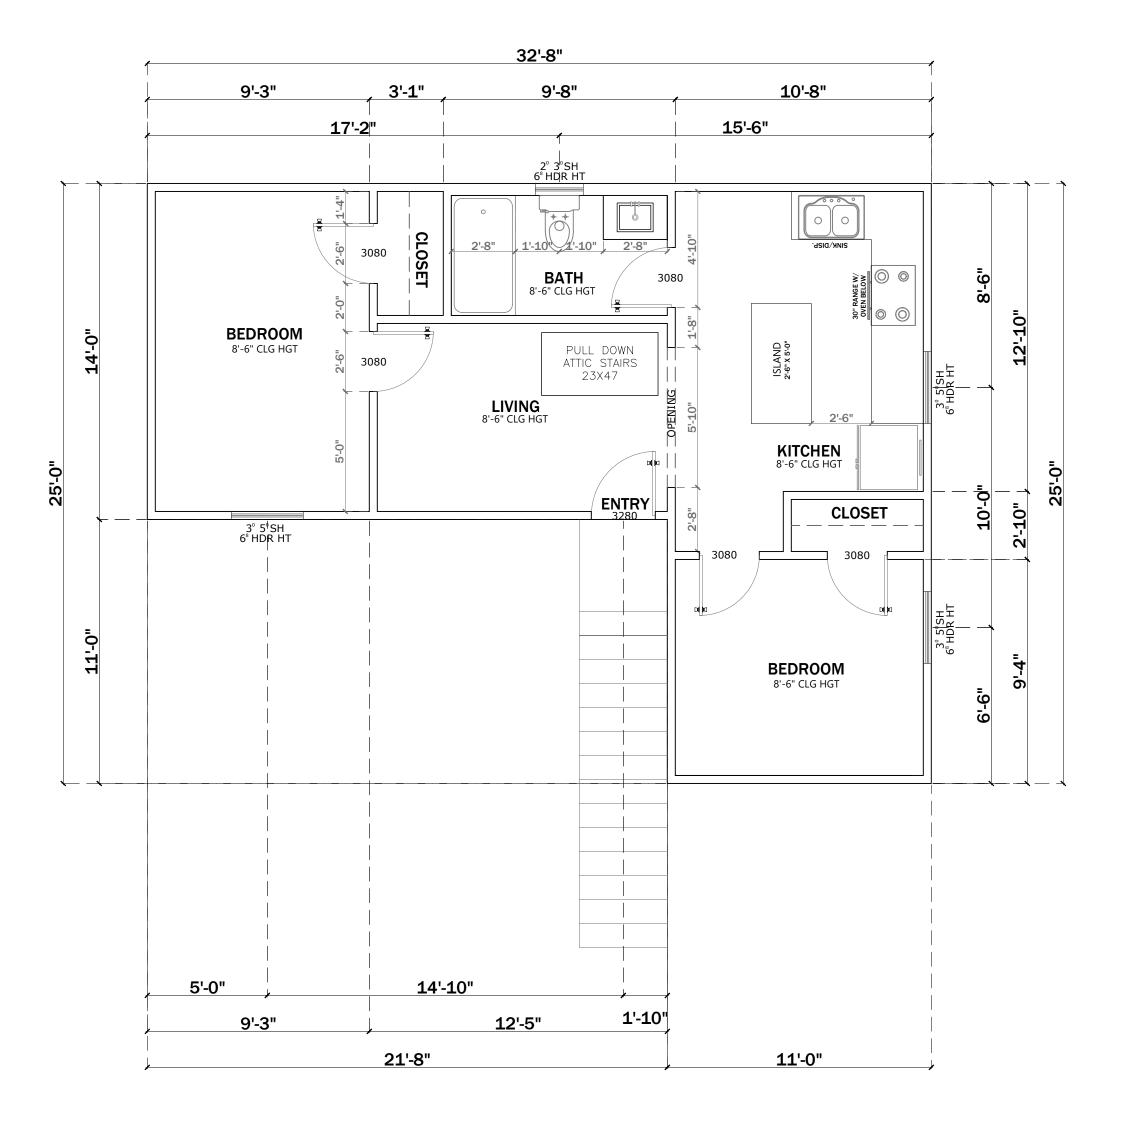

SECOND FLOOR (Unit 2)

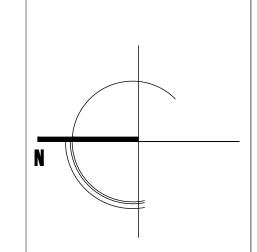

Projecta engineering processor and another the complex projects and pr

105 TERREL AVE.

San Antonio, TX. 78214

DATE: 08/16/2022
PROJECT NO.

REVISION DATE

1
2
3
4
5
6

NOTES:

THESE PLANS ARE INTENDED TO PROVIDE BASIC CONSTRUCTION INFORMATION NECESSARY TO SUBSTANTIALLY BUILD THIS STRUCTURE. THESE PLANS MUST BE VERIFIED AND CHECKED BY THE BUILDER, HOMEOWNER, AND ALL CONTRACTORS OF THIS JOB PRIOR TO CONSTRUCTION, BUILDER SHOULD OBTAIN COMPLETE ENGINEERING BEGINNING CONSTRUCTION OF ANY KIND. NOTE: ALL FEDERAL, STATE, AND LOCAL CODES AND RESTRICTIONS TAKE PRECEDENCE OVER ANY PART OF THESE PLANS, BECAUSE OF THE VARIANCE IN GEOGRAPHIC LOCATIONS, DESIGNER WILL NOT ERRORS, OMISSIONS, OR DEFICIENCIES ON THESE PLANS, OWNER/BUILDER MUST COMPLY WITH LOCAL BUILDING CODES PRIOR TO COMMENCEMENT OF CONSTRICTION, ANY COPYING TRACING. OR ALTERING OF THESE PLANS IS NO PERMITTED, VIOLATORS WILL BE SUBJECT TO

DRAWN BY: CLAUDIA GONZALEZ

RESIDENTIAL

PROSECUTION UNDER COPYRIGHT LAWS

PROJECT TYPE:

LIVING SPACE: 823 SQFT

FLOOR PLAN

SCALE: 1/4"=1'-0"

A.002

ACN 2022

ELECTRICAL LEGEND=

CEILING MOUNT LIGHT WALL MOUNT LIGTH

CEILING FAN

FLUORESCENT LIGHT FIXTURE

\$ WP\$ 3\$ 4\$ SWITCHES: SINGLE POLE, WEATHER PROOF, 3-WAY, 4WAY

110V RECEPTACLES: DUPLEX, WEATHER PROOF, GFCI

220V RECEPTACLES SMOKE DETECTOR


EXHAUST VENT / LIGTH / HEATER COMBO

VOICE / DATA OUTLET

ELECTRIC PANEL

ELECTRICAL NOTES =

- ALL ELECTRICAL DEVICES AND WORK COMPLY WITH THE STANDARD OF THE
- PERFORMANCE STANDARDS CONFORM ALL APPLICABLE CODES AND REGULATIONS
- PROVIDE A MINIMUM OF ONE SEPARATE 20AMP CIRCUIT TO LAUNDRY APPLIANCES
- PROVIDE A MINIMUM OF TOW SEPARATE 20AMP CIRCUIT TO THE KITCHEN APPLIANCES
- APPLICABLE LAW, CODES OR STANDARD FOR THE SPECIFY OCCUPANCY.
- BLUE PVC BOXES SUCH AS 18cu Single box, 32cu double box AND 44cu triple box SHALL BE INSTALLED AND USED AS THE PROJECT'S NEEDS AND REQUIRED BY
- SWITCHES, RECEPTACLES OUTLETS, GFCI RECEPTACLES, 10-50R 3 POLE RECEPTACLE, WATER PROOF OUTLETS AND LED LIGHTS SHALL BE INSTALLED AS THE PROJECT'S NEEDS AND REQUIRED BY CODE.
- PANEL BOARDS AND EXHAUST FANS SHALL BE INSTALLED AS THE PROJECT'S NEEDS AND REQUIRED BY CODE.
- 10. REFRIGERATOR OUTLET HAVE IT'S OWN DEDICATED CIRCUIT AS REQUIRED BY CODE.
- 11. ALL COVER PLATES FOR ALL DEVICES SHALL BE PROVIDE IN THE COORDINATED COLOR TO MATCH SURROUNDINGS.
- 12. ALL DEVICES SHALL BE U.L. APPROVED AND BEAR U.L. LABELS.
- 13. VERIFY SERVICES AND LOCATION REQUIREMENTS FOR ALL APPLIANCES AND MECHANICAL EQUIPMENT PRIOR TO INSTALLATION.
- 14. 220V RANGE TO BE ON A DEDICATED CIRCUIT PER ELECTRICAL CODE REQUIREMENTS.
- 15. THE CONTRACTOR SHALL WIRE SEPARATE DEDICATED CIRCUITS FOR REQUIRED NUMBER OF OUTLETS STATED BY CODE IN KITCHEN AREA
- 16. BREAKER BOX TO BE INSTALLED AT 48" A.F.F. TO ITS HIGHEST OPERABLE PART.

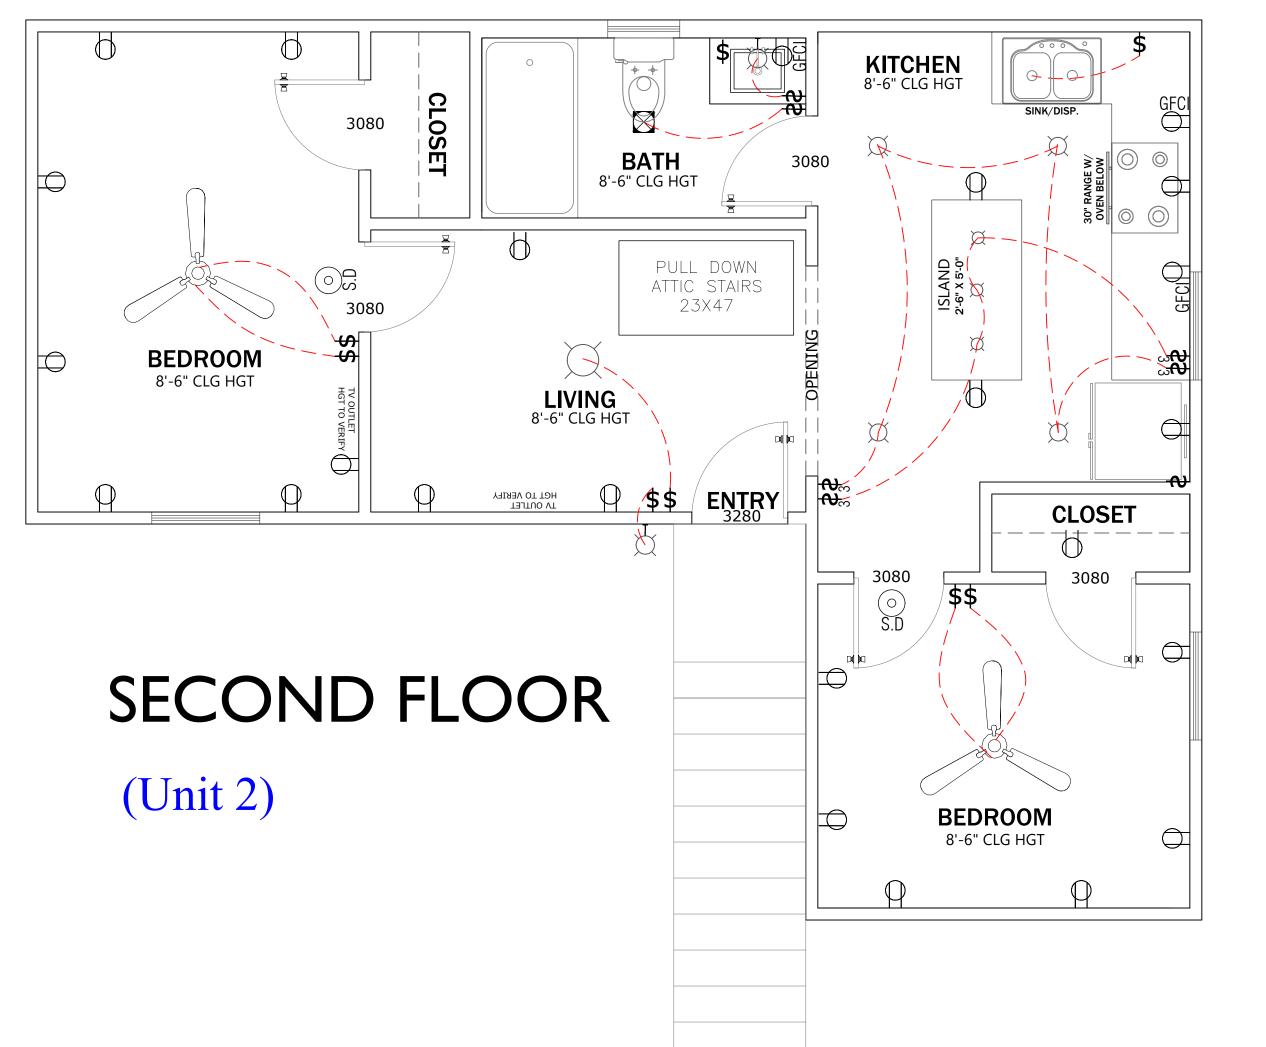


CLOSET **KITCHEN** 8'-6" CLG HGT нет то уевгеу **BATH** /8'-6" CLG HGT **BEDROOM** 8'-6" CLG HGT **DECK** 8'- 6" CLG HGT ENTRY FIRST FLOOR (Unit 1) __________

Z-2022-10700290 CD

From: "R-6" Residential Single-Family District

To: "R-6 CD" Residential Single-Family District with a Conditional Use for Two (2) Dwelling Units

I, Bryan Maldonado, the property owner, acknowledge that this site plan submitted for the purpose of rezoning this property is in accordance with all applicable provisions of the Unified Development Code. Additionally, I understand that City Council approval of a site plan in conjunction with a rezoning case does not relieve me from adherence to any/all Cityadopted Codes at the time of plan submittal for building permits.

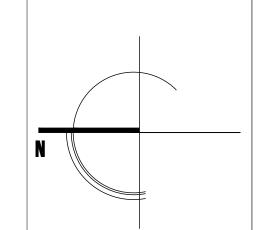



105 TERRELL

AVE.

San Antonio, TX. 78214

DRAWN BY: CLAUDIA GONZALEZ

THESE PLANS ARE INTENDED TO PROVIDE BASIC

CONSTRUCTION INFORMATION NECESSARY TO SUBSTANTIALLY BUILD THIS STRUCTURE. THES PLANS MUST BE VERIFIED AND CHECKED BY THE BUILDER, HOMEOWNER, AND ALL CONTRACTORS OF THIS JOB PRIOR TO CONSTRUCTION, BUILDER SHOULD OBTAIN COMPLETE ENGINEERING SERVICES, HVAC, AND STRUCTURAL BEFORE BEGINNING CONSTRUCTION OF ANY KIND NOTE: ALL FEDERAL, STATE, AND LOCAL CODES AND RESTRICTIONS TAKE PRECEDENCE OVER ANY PART OF THESE PLANS. BECAUSE OF THE VARIANCE IN GEOGRAPHIC LOCATIONS, DESIGNER WILL NOT ASSUME LIABILITY FOR ANY DAMAGES DUE TO ERRORS, OMISSIONS, OR DEFICIENCIES ON THES PLANS, OWNER/BUILDER MUST COMPLY WITH LOCAL BUILDING CODES PRIOR TO COMMENCEMENT OF CONSTRICTION, ANY COPYING TRACING. OR ALTERING OF THESE PLANS IS NO PERMITTED. VIOLATORS WILL BE SUBJECT TO PROSECUTION UNDER COPYRIGHT LAWS PROJECT TYPE:


RESIDENTIAL

LIVING SPACE: 823 SQFT

ELECTRICAL

PLAN

105 Terrell Avenue

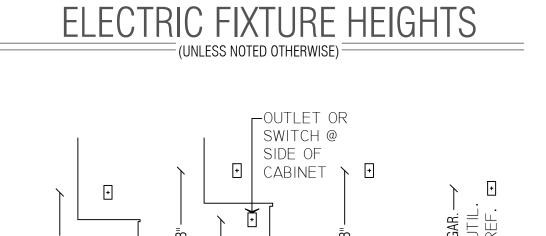

@ @ @ TYP. WALL REFRIG., GARAGE, OR

UTILITY

OUTLET

SCALE: 3/8"=1'-0"

A.003

AGO 2022



ELECTRICAL PLAN